

NOIL

**ERS** 

ENERGY

HYDRAULIC

MECHANIC

About Marline Engineering Newcastle

At Marline, we take a comprehensive approach when designing your new development

With in-house electrical, mechanical and hydraulic engineers, Marline Engineering makes your engineering design needs a breeze. We are able to adjust, implement and create designs on AutoCAD and REVIT which makes it easy for contractors and builders to build our designs.

We advise you on the most affordable, practical and effective solutions and system based on the site and legal factors.

As consulting engineers, Marline has also expanded the range of services to provide a wide range of building services disciplines including Air-conditioning, Electrical, Hydraulies, Fire Protection and Lift Services.

Marline has seen a buge amount of growth in the Energy sector. We provide services that go above and beyond the standard regulatory requirements and offer unique solutions to your Section J or JV3

Alternative solution reports. We also offer a fast NABERS and BEEC certification that ensures advertising for commercial properties are fully compliant with the CBD advertising rules and regulations.

With engineering consulting experience that dates back as far as 1975, we're one of the best engineering companies in Australia, and have developed the kind of projects that residential and commercial property developers benefit from.

Our Newcastle engineering firm continues to grow, however our team prides itself on every customer receiving the kind of high quality workmanship and personalised service that our company is known for.

To accommodate the expansion and demand for engineering services within Newcastle and throughout New South Wales, Marline Engineering has almost doubled the number of highly trained employees in the last five years.

Our engineering firm currently employs ten engineers, eight technical assistants and an office administrator. As a result, we continue to be leaders amongst engineering companies in Australia, with a large portfolio and a positive attitude.

PROJECT No: MN14834

CLIENT:
WEDGETAIL PROJECT CONSULTING

ARCHITECT:

# Fire Sprinkler Services

# PROPOSED EXTENSION WOOD WASTE PROCESSING BUILDING ANL TEA GARDENS, PINDIMAR ROAD, TEA GARDENS, NSW 2324

# DRAWING SCHEDULE

FS-00-000 COVER SHEET FS-00-001 LEGEND & NOTES

FS-10-001 WOOD WASTE PROCESSING BUILDING - FIRE SPRINKLER LAYOUT

100% ISSUE

FIRE SPRINKLER SERVICES

FS-00-000

### LINETYPES - EXISTING

------ eSP ------ SPRINKLER ewd — WINDOW DRENCHER —/// DISUSE PIPE

### LINETYPES - NEW

SPRINKLER 

### **SYMBOLS**

FIP

**→><** 

 $\bigcirc$ DELETED EXPOSED SPRINKLER 0 EXISTING EXPOSED SPRINKLER NEW EXPOSED SPRINKLER DELETED CONCEALED SPRINKLER EXISTING CONCEALED SPRINKLER NEW CONCEALED SPRINKLER DELETED FULLY RECESSED CEILING SPRINKLER EXISTING FULLY RECESSED CEILING SPRINKLER NEW FULLY RECESSED CEILING SPRINKLER DELETED SIDE WALL SPRINKLER EXISTING SIDE WALL SPRINKLER NEW SIDE WALL SPRINKLER DELETED WINDOW/WALL WETTING DRENCHER EXISTING WINDOW/WALL WETTING DRENCHER NEW WINDOW/WALL WETTING DRENCHER ALARM STROBE

FIRE INDICATOR PANEL

SPRINKLER PUMP SET

SPRINKLER VALVE SET

SPRINKLER TEST POINT

## SYMBOLS - FIRE

**BOOSTER ASSEMBLY** PUMP SET VALVE SET **→>>+>** TEST POINT ALARM STROBE SINGLE PILLAR HYDRANT (INTERNAL) DOUBLE PILLAR HYDRANT (EXTERNAL) STREET HYDRANT FIRE HOSE REEL THRUST BLOCK

FIRE INDICATOR PANEL

### **ABBREVIATIONS**

EXISTING. SPRINKLER VALVE SET. SVS WD WINDOW DRENCHER. WDE WINDOW DRENCHER EXTERNAL. WINDOW DRENCHER INTERNAL

### **GENERAL NOTES**

- 1. ALL RANGE PIPES TO ONE HEAD SHALL BE 25mm UNLESS NOTED OTHERWISE.
- 2. ALLOW TO DRAIN DOWN, TEST, REFILL & COMMISSION THE SYSTEM & RECHARGE AS NECESSARY TO UNDERTAKE THE WORKS REQUIRED.
- 3. ALLOW TO SUPPLY & INSTALL AS ADDITIONAL 20 SPRINKLER HEADS FOR COORDINATION.
- 4. SPRINKLER HEAD IN CEILING SHALL BE LOW PROFILE MINIMATICS TYPE WITH TWO PIECE ESCUTCHEON PLATE. THE HEADS & ESCUTCHEON PLATES SHALL BE POWDER COATED TO A COLOUR NOMINATED BY THE ARCHITECT.
- 5. NUMBER & LOCATIONS OF HEADS OF PIPEWORK IS INDICATIVE ONLY. IT IS THE CONTRACTOR'S RESPONSIBILITY TO ENSURE COMPLIANCE WITH AS2118.4 -RESIDENTIAL CODE. THE CONTRACTOR IS TO SUBMIT WORKSHOP DRAWINGS OF THE PROPOSED DESIGN & CALCULATIONS FOR APPROVAL PRIOR TO COMMENCEMENT OF WORKS. ALL SPRINKLERS TO BE LOCATED CLEAR OF ALL LIGHT FITTINGS, EXIT SIGNS ETC WHICH WILL IMPEDE OPERATION OF THE HEADS.
- 6. IT IS THE CONTRACTORS RESPONSIBILITY TO FULLY COORDINATE THE LOCATION OF ALL SPRINKLER HEADS & PIPEWORK WITH OTHER SERVICES (ie. STRUCTURAL, LIGHT FITTINGS, SMOKE DETECTORS ETC) PRIOR TO THE INSTALLATION OF ANY WORKS.
- 7. OPERATION & MAINTENANCE MANUALS. MANUALS & DRAWINGS SHALL BE PRODUCED & SUBMITTED IN ACCORDANCE WITH THE SUPERINTENDENT'S REQUIREMENTS.
- 8. INSTALLATION TO COMPLY WITH THE REQUIREMENTS OF AS2118.
- 9. NOTE VOID SPRINKLERS HEADS SHALL BE IN ACCORDANCE WITH THE HAZARD CLASSIFICATION REQUIRED UNDER AS2118.1-2017 AND INCORPORATE APPROVED PROTECTION METAL GUARD
- 10. SPRINKLER CONTRACTOR TO RUN WIRING TO FIP. COORDINATE WITH ELECTRICIAN.
- 11. EXACT POSITION OF CEILING SPRINKLER HEADS SHALL BE DETERMINED FOLLOWING INSTALLATION OF ROOF TRUSSES & CONFIRMATION OF SKYLIGHT SHAFT LOCATIONS. COORDINATE WITH OTHER SERVICES & OBTAIN APPROVAL PRIOR TO INSTALLATION.
- 12. (FCS)DENOTES FIRE STOP COLLAR WHERE PVC PIPE PENETRATES FIRE RATED WALL.
- 13. FINAL SPACING & COVERAGE OF ROOF SPACE FIRE SPRINKLERS SHALL BE IN ACCORDANCE WITH AS2118.1 "LIGHT HAZARD" PROTECTION.
- 14. FINAL SPACING & COVERAGE OF BELOW CEILING SPRINKLERS SHALL BE IN ACCORDANCE WITH AS2118.1.
- 15. ALL SPRINKLER HEADS TO BE MIN 300mm FROM ANY SUPPLY AIR DIFFUSER.
- 16. ALL SPRINKLER WITHIN 600mm OF A SUPPLY DIFFUSER TO BE RATED AT 79°C.


This drawing is not to be used for any construction purpose unless noted otherwise in the issue column. Marline Newcastle pty ltd. accept no responsibility for any unauthorised use of drawings issued on a "information and discussion"

4 21.08.24 100% ISSUE 3 02.07.24 100% ISSUE FOR REVIEW 2 19.06.24 REVISED AS REQUESTED 1 | 11.06.24 | 50% ISSUE FOR REVIEW

JC CB DW PROPOSED EXTENSION WOOD WASTE PROCESSING BUILDING ANL TEA GARDENS PINDIMAR ROAD, TEA GARDENS, NSW 2324

Scale N.T.S @ A1 FIRE SPRINKLER SERVICES

LEGEND & NOTES

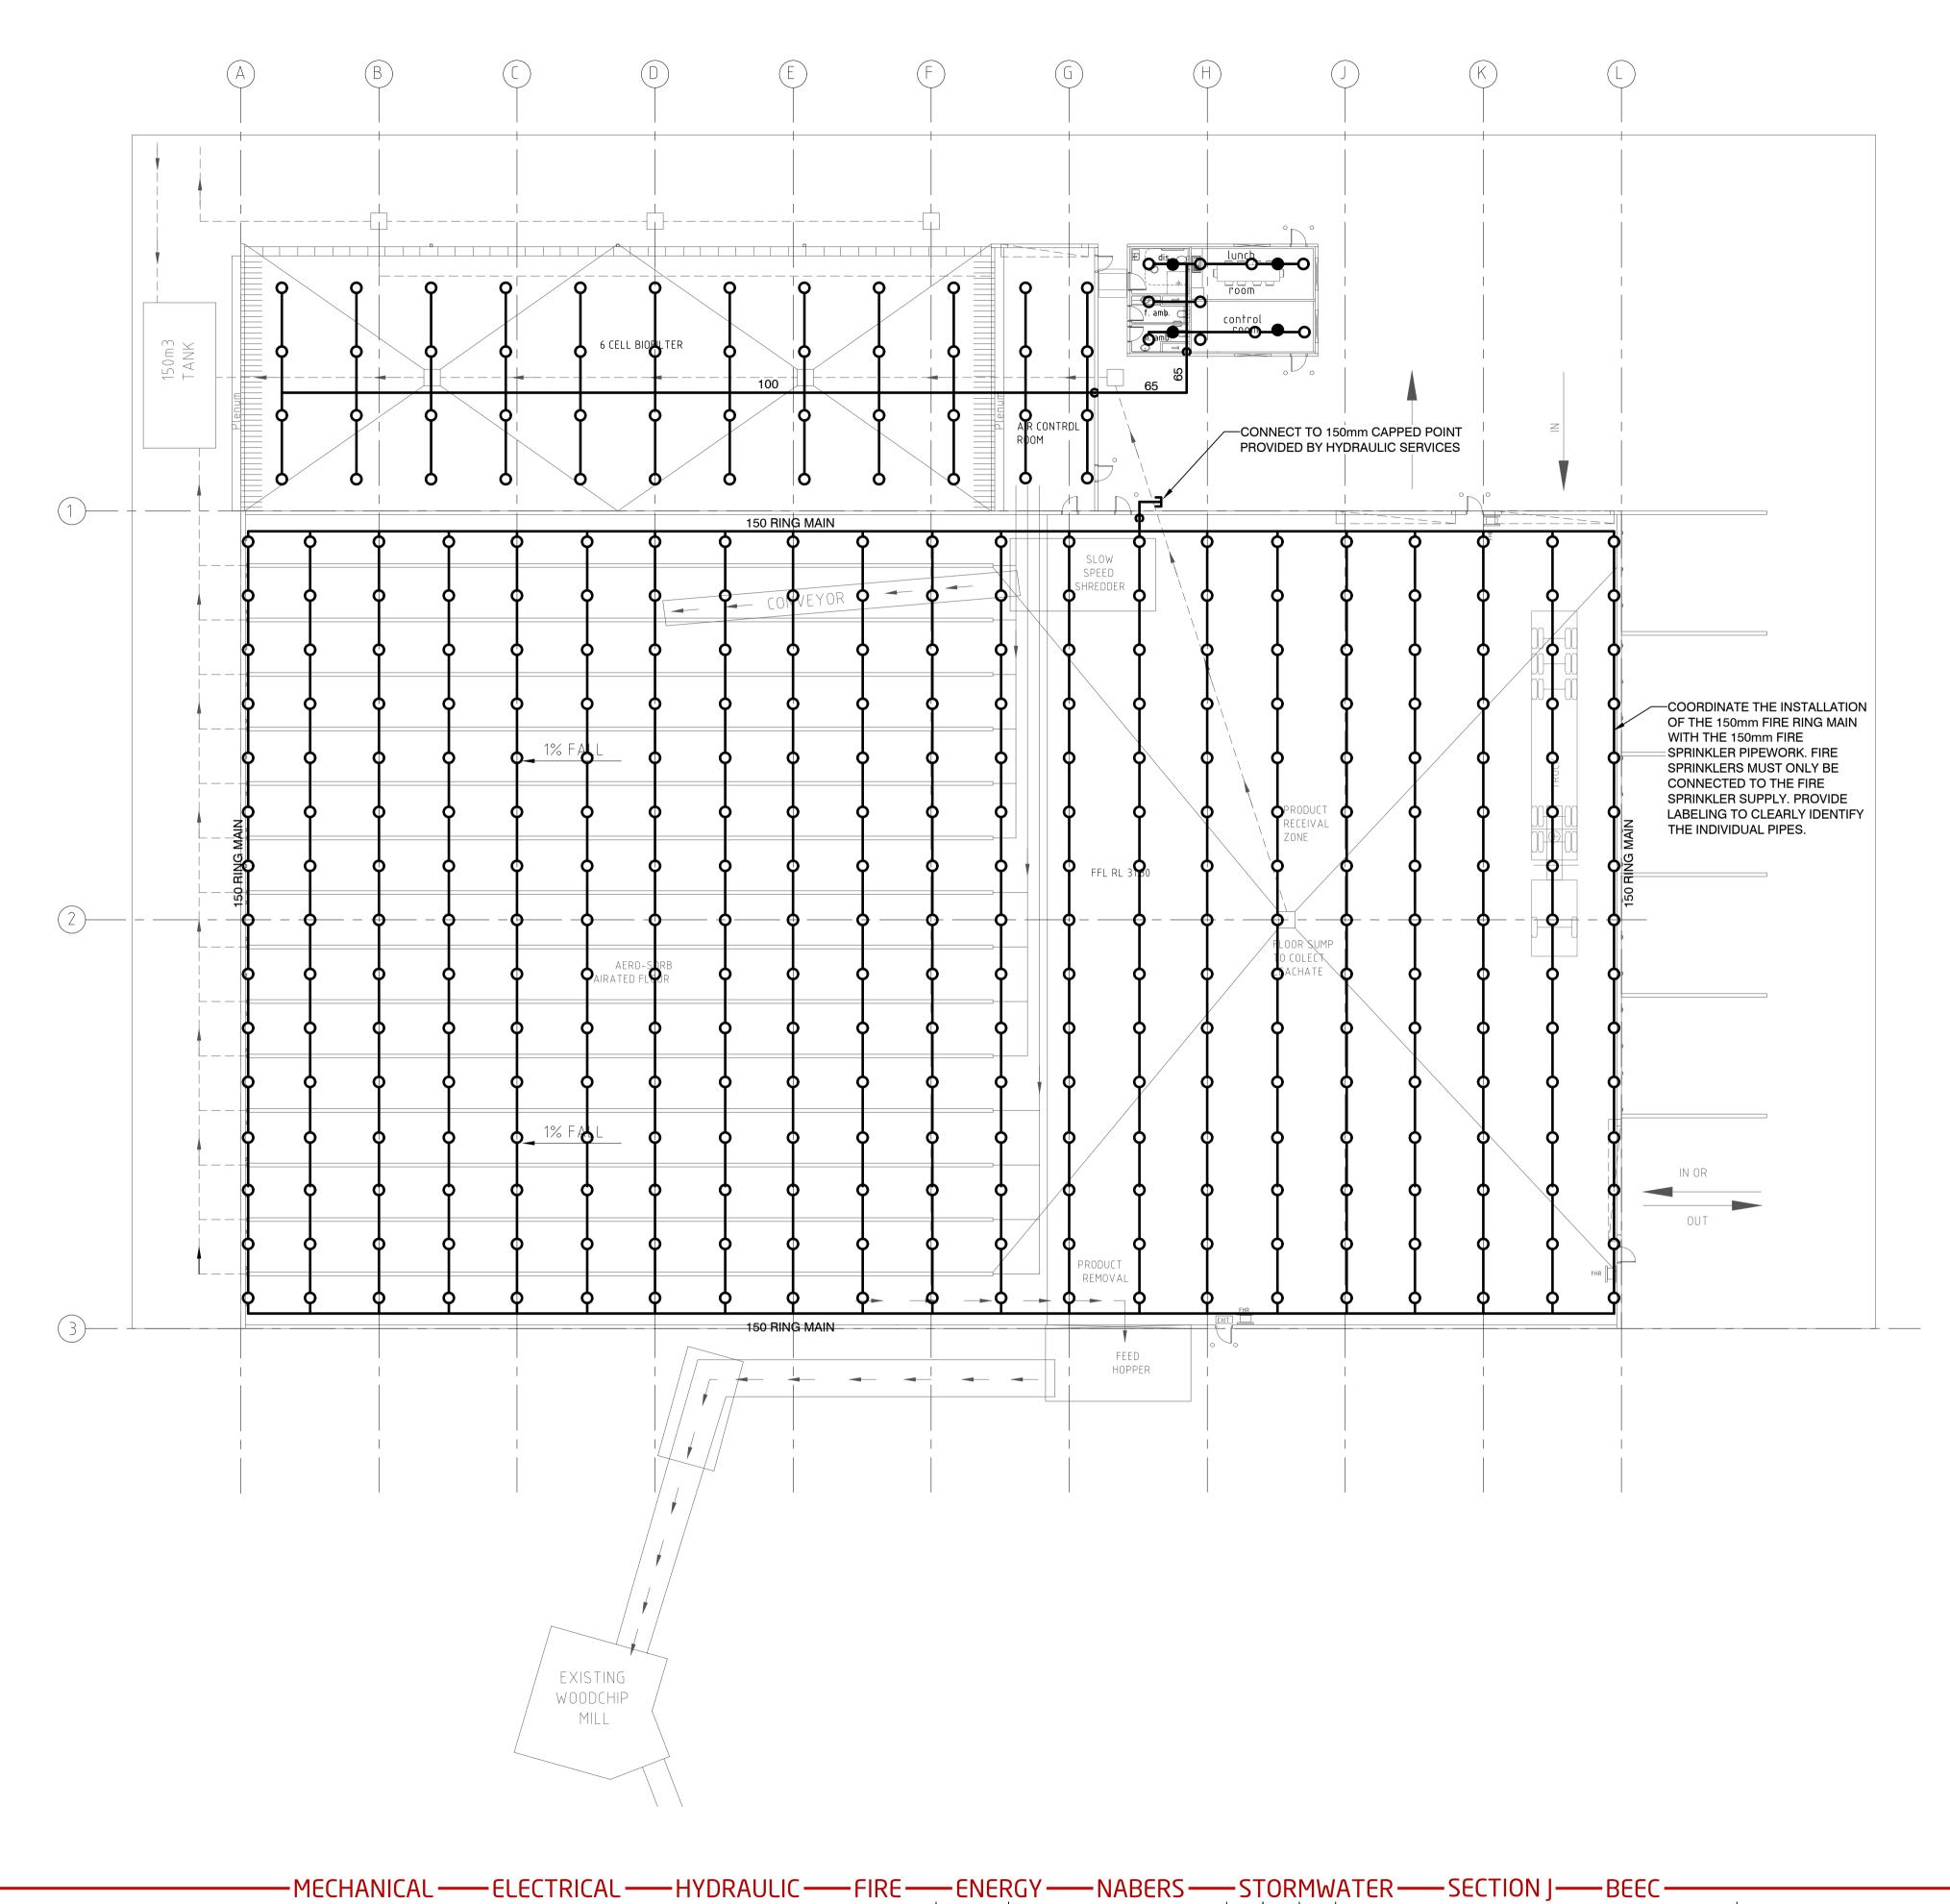



This drawing is not to be used for any construction purpose unless noted otherwise in the issue column. Marline Newcastle pty ltd. accept no responsibility for any unauthorised use of drawings issued on a "information and discussion"



1 11.06.24

4 21.08.24 100% ISSUE 3 02.07.24 100% ISSUE FOR REVIEW 2 19.06.24 REVISED AS REQUESTED 50% ISSUE FOR REVIEW

JC CB DW Project PROPOSED EXTENSION WOOD WASTE PROCESSING BUILDING ANL TEA GARDENS
Drawn Design Verify Project PROPOSED EXTENSION WOOD WASTE PROCESSING BUILDING ANL TEA GARDENS, NSW 2324

WOOD WASTE PROCESSING BUILDING FIRE SPRINKLER LAYOUT

Discipline Scale 1:200 @ A1 FIRE SPRINKLER SERVICES Drawing No. **FS-10-001** 

MN14834